

	5	145 FEET	125 FEET
METAL DRY OR EQUAL.	TION SOLUTIONS MODEL D ER VENT BOX FIRE RATED, OWNER SUPPLIED DRYERS PROVIDED WITH EXTRA LOVENTING. SEE ATTACHED MANUFACTURUER'S LITERA	SARE NG	PROVIDE A LABEL FOR EACH DRYER VENT BOX WITH THE DRYER VENT LENGTH AND NUMBER OF ELBOWS. 4" Ø SHEET METAL DUCT TO DRYER VENT. 4" Ø FLEXIBLE CORRUGATED SHEET METAL DUCT TO DRYER, WITH CLAMP.
	FIN	IISHED FLOOR	ADJUST A.F.F. HEIGHT BASED ON SPECIFIED EQUIPMENT

RESIDENTIAL EXHAUST FAN (EF) SCHEDULE LEVEL 1												
TAG	MANUF.	ROOM NAME	AIR SYSTEM TYPE	MODEL NO.	AIRFLOW	STATIC PRESS.	WATTS	VOLT	PHASE	FREQ.	INTERLOCK	NOTES
EF-1BR-A	BROAN	1BR-A	CEILING MOUNTED	SP-B80	50 CFM	0.30 in-wg	30.6 W	115 V	1	60 Hz	LIGHTS	LEVEL 1

***CONTRACTOR SHALL READ ALL GENERAL NOTES
AND KEYED NOTES PRIOR TO BIDDING. IF ANY
QUESTIONS OR CLARIFICATIONS ARE REQUIRED,
CONTACT ENGINEER OF RECORD WITH REQUEST
FOR INFORMATION PRIOR TO BIDDING.

*** MECHANICAL CONTRACTOR SHALL PROVIDE A PRICE FOR FULL COUNT OF ALL MOTORIZED CONTROL VALVE AND BALL VALVES, TAKE OFF FROM THE MECHANICAL 200 SERIES DIAGRAM PROVIDED

CFM RANGE RECTANGULAR DUCT SIZE (WIDTH X HEIGHT @ 0.10 IN. W.C. / 100 FT)	
Ø-135 6" × 6" 6.56" EQ. DIA.	
140-175 8" × 6" 1.55 " EQ. DIA.	
18Ø-29Ø 8" × 8" 8.75" EQ. DIA.	
295-400 10" × 8" 9.76" EQ. DIA.	
4Ø5-855 12" × 12" 13.12 " EQ. DIA.	
860-1290 14" × 14" 15.30 EQ. DIA.	

PROVIDE RECTANGULAR DUCTS TAKE-OFF. TRANSITION TO ROUND DUCT USE TABLE THIS SHEET FOR ROUND DUCT.

NOTES:

R	DUND DUCT SIZE						
CFM RANGE	MINIMUM INTERNAL DIA.® Ø.IØ IN, W.C. / IØØ FT)						
0-110	6"						
115-145	"ד						
150-230	8"						
235-455	10"						
460-685	12"						
690-1015	14"						
NOTES:							
II. PROVIDE F	I. PROVIDE ROUND DUCTS UNLESS OTHERWISE NOTED ON FLOOR						

1. PROVIDE ROUND DUCTS UNLESS OTHERWISE NOTED ON FLOOR PLAN.

2. "DIAMETER" MEANS INSIDE DUCT DIAMETER.

GENERAL NOTES:

- WORK SHALL INCLUDE ALL MATERIALS, EQUIPMENT AND LABOR FOR A COMPLETE AND PROPERLY FUNCTION
 MECHANICAL INSTALLATION IN ACCORDANCE WITH THE FLORIDA BUILDING CODE SEVENTH EDITION (2020),
 MECHANICAL CODE, FUEL GAS CODE AND LOCAL CODES HAVING JURISDICTION.
- THE GENERAL NOTES ARE PART OF THE DESIGN SET AND IF THERE IS ANY CONFLICT BETWEEN THE DESIGN NOTES,
 SPECIFICATIONS OR THE FLORIDA BUILDING CODE. THE STRICTER REQUIREMENTS SHALL TAKE PRIORITY.
 FIELD VERIFY EXISTING CONDITIONS PRIOR TO DEMOLITION OF ANY MECHANICAL EQUIPMENT. CAREFULLY REMOVE
 EXISTING SPIRAL DUCTWORK AND REUSE EXISTING DUCT WORK WHEREVER POSSIBLE.
- REMOVE EXISTING HVAC EQUIPMENT AS REQUIRED. COORDINATE WITH ELECTRICAL CONTRACTOR TO DISCONNECT POWER TO HVAC EQUIPMENT BEING REMOVED.
- 5. COORDINATE NEW WALL OPENING LOCATION AND SIZE WITH GENERAL CONTRACTOR.
- PROVIDE ALL NECESSARY AND OPTIONAL HARDWARE, FITTINGS, ESCUTCHEONS, ETC., AS REQUIRED TO ASSURE THE SYSTEM WORK PROPERLY.

 7. LISE 4" CONCRETE BAD FOR CONDENSERS ON CROUND AND PROVIDE HURBICANE TIE DOWNS.
- 7. USE 4" CONCRETE PAD FOR CONDENSERS ON GROUND AND PROVIDE HURRICANE TIE DOWNS.

 8. PIPE AND DUCT ROUTING SHOWN IS SCHEMATIC IN DESIGN. HVAC CONTRACTOR SHALL PROVIDE ANY ADDITIONAL OFFSETS AND FITTINGS, INCLUDING DIVIDED DUCTS REQUIRED FOR PROPER INSTALLATION AND TO MAINTAIN
- CLEARANCES AS ENCOUNTERED IN THE FIELD. WORK SHALL BE COORDINATED WITH EXISTING UTILITIES WHICH ARE TO REMAIN IN PLACE.

 9. COORDINATE WITH ALL OTHER TRADES PRIOR TO PURCHASING OR INSTALLING EQUIPMENT AND MATERIALS.
- 10. COORDINATE DIFFUSER, REGISTERS AND GRILLE LOCATIONS WITH ARCHITECTURAL REFLECTED CEILING PLAN AND OTHER TRADES.
- 11. DUCT TO BE SUPER DUCT JOHNS MANVILLE FIBERBOARD WITH R6.4, 1.5" THICK INSULATION OR EQUAL. ALL DUCT SHALL BE PER SMACNA GUIDELINES. ALL EXPOSED DUCTWORK IS TO BE SPRIAL DUCTWORK WITH ALL NECESSARY MANUFACTUERE FITTINGS. PROVIDE AIR EXTRACTORS WHERE NECESSARY.
- 12. THERMOSTATS SHALL BE PROGRAMMABLE WITH HUMIDITY CONTROL AND MOUNTED 48 INCHES ABOVE FINISHED FLOOR PER ADA REQUIREMENTS.
- DUCT SIZES ARE SHOWN MINIMUM INSIDE CLEAR DIMENSIONS. COORDINATE FOR DUCT INSULATION THICKNESS AT
- DUCT SIZES ARE SHOWN MINIMUM INSIDE CLEAR DIMENSIONS. COORDINATE FOR DUCT INSULATION THICKNES
 POINT OF INTERSECTION WITH OTHER TRADES PRIOR TO INSTALLATION.
- 14. AIR INTAKES SHALL BE INSTALLED A MINIMUM 10'-0" (FEET) FROM OUTSIDE EXHAUST AIR OUTLETS.
 15. SEAL ALL DUCTWORK JOINTS WITH DUCT SEALANT PER MANUFACTURER'S REQUIREMENTS AND PER THE FLORIDA
- BUILDING CODES. .

 16. PROVIDE TESTING AND BALANCING IN ACCORDANCE WITH AARC OR NERR STANDARDS. TEST AND BALANCE.
- 16. PROVIDE TESTING AND BALANCING IN ACCORDANCE WITH AABC OR NEBB STANDARDS. TEST AND BALANCE CONTRACTOR SHALL HAVE A COPY OF FINAL TEST AND BALANCE REPORT AVAILABLE AT FINAL INSPECTION PROVIDE TEST AND BALANCE IN ACCORDANCE WITH AABC OR NEBB STANDARDS. BALANCE ALL EQUIPMENT AND AIR DEVICES AIRFLOWS TO WITHIN +/- 10° OF DESIGN.
- 17. ALL OUTSIDE AIR INTAKES AND EXHAUST AIR DUCTS SHALL BE GALVANIZED SHEETMETAL MANUFACTURED ACCORDING TO SMACNA.
 18. ALL DIFFUSERS SHALL HAVE A MANUAL VOLUME DAMPER AT DUCT CONNECTION WHETHER SHOWN ON THE DRAWING
- 19. CONNECT ALL CONDENSATE DRAIN TO STORM DRAIN, DRYWELL OR OUTDOOR LANDSCAPE COORDINATE WITH PLUMB. CONTRACTOR. PLUMBING CONTRACTOR SHALL COORDINATE DRAIN SYSTEM WITH CIVIL CONTRACTOR.
- 20. ALL RECTANGULAR DUCT ELBOWS 45°OR LARGER SHALL HAVE TURNING VANES IN THEM.
- PROVIDE ALL OUTSIDE AIR INTAKE DUCT WITH TWO POSITION (SPRING RETURN) MOTORIZED DAMPER AND MANUAL VOLUME DAMPER.


22. CONDENSATE DRAIN PIPING SHALL BE PVC, INSULATED WITH 1/2" THICK ARMFLEX AND SLOPED 1/8" PER LINEAR FOOT.

	RESIDENTIAL AIR HANDLER UNIT (FC) SCHEDULE LEVEL 1																		
TAG																			
FC-A102	ADP	SM212419	1BR-C	705	75.0 / 62.5	55.0 / 55.0	20860	.5	208 / 1 / 60	3.75 / 1	27.0	30.0	22" x 30" x 20.8"	CU-FC-A101	16ACX24	15.6	20.0	16.0	LEVEL 1

(FC) RESIDENTIAL SCHEDULE NOTES:

- PROVIDE WITH PROGRAMMABLE THERMOSTAT WITH REMOTE SENSOR,
- HUMIDSTAT.
 2. COORDINATE MANUFACTURER REQUIREMENTS FOR LONG REFRIGERANT
- LINES AND ACCESSORIES PRIOR TO CONSTRUCTION.

 3. AIR HANDLER UNITS CLEARANCE 36" IN FRONT FOR ELECTRICAL ACCESS PANEL AND 12" MINIMUM CLEARANCE BETWEEN THE OTHER
- THREE SIDES. 4. PROVIDE WITH UNITS WITH TWO (2) YEAR WARRANTY ON PARTS AND LABOR
- AND FIVE (5) YEAR WARRANTY ON THE COMPRESSOR
- 5. PROVIDE AHU UNITS WITH DISCONNECT SWITCH.
 6. COORDINATE MANUFACTURER'S INSTALLATION RECOMMENDATIONS.
 7. TRANE, CARRIER, AAON AND JOHNSON CONTROLS ARE ACCEPTABLE ALTERNATIVE, HOWEVER GENERAL CONTRACTOR IS RESPONSBILE FOR ALL
- MODIFICATIONS OF DUCTWORK RESULTING FROM ALTERNATE CHANGE DESIGN.
- 8. CONTRACTOR SHALL COORDINATE EQUIPMENT LOCATION WITH ALL TRADES PRIOR TO INSTALLATION.
- 9. CONDENSATE PIPING TO BE PROVIDED FROM AHU TO EXISTING SANITARY DRAIN LINE AT 3/4" SIZE. GRAVITY DRAINAGE TO BE USED IN LIEU OF CONDENSATE PUMP.
- 10. A 12"X24" RETURN GRILL SHALL BE LOCATED AT THE AHU CLOSET AS RETURN, AND A 6"X8" TRANSFER GRILL SHALL BE LOCATED ABOVE BEDROOMS AND BATHROOM DOORS.

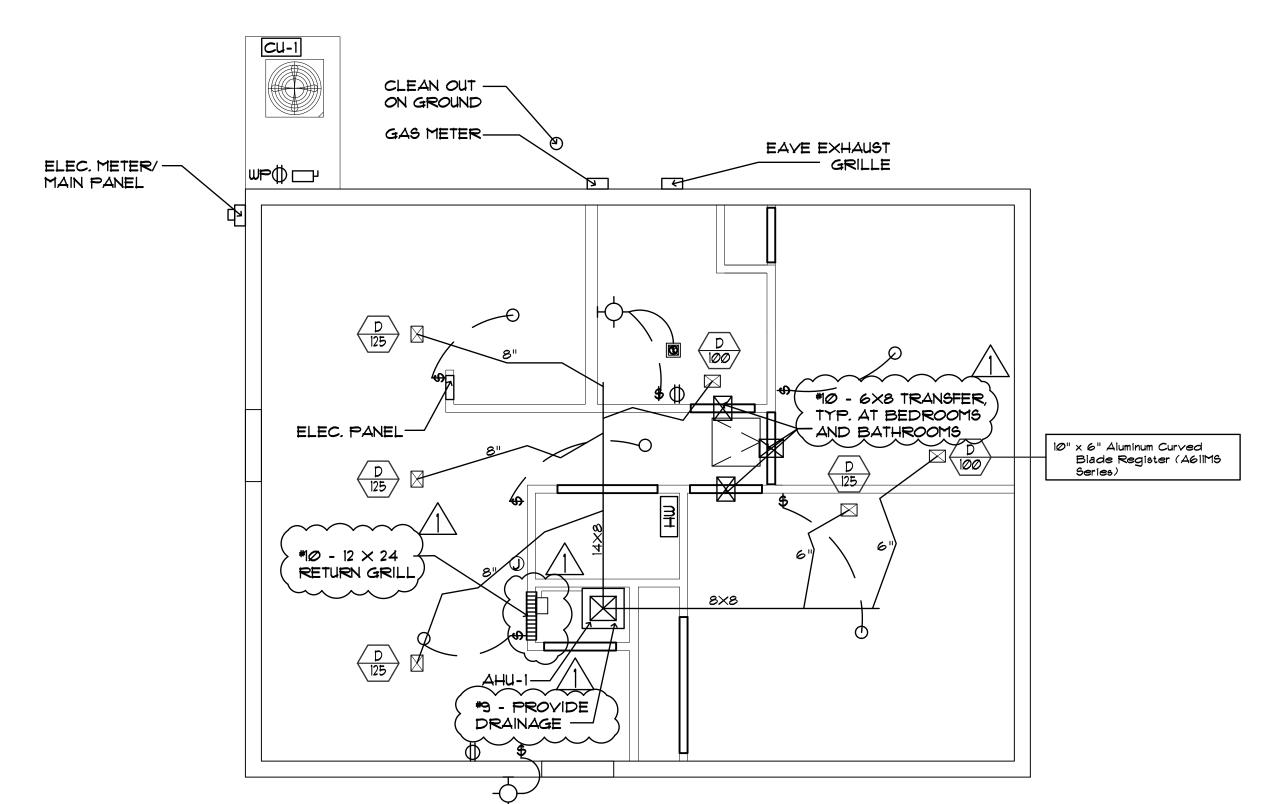





NOTE:

REMOVE EXISTING DUCT WORK, REFRIGERATION
PIPING AND REPLACE WITH NEW DUCT WORK, AND
REFRIGERATION PIPING.



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	ISSUED
DATE:	ISSUED FOR:

	REVISIONS										
NO:	DATE:	DESCRIPTION									
1	11/22/2023	ADDENDUM 1									
ᆫ											

PROJECT NO:	
DRAWN BY: T	ș <u>ș</u>
PROJECT MANAGER:	
CHECKED BY: K	JB.
DATE:	
SCALE: 1/4" = 1'-	0"



MECHANICAL FLOOR PLAN